

### **GENERAL NOTES**

- 1. THE ORIGINAL TOPOGRAPHY, GROUND ELEVATION AND SURVEY DATA SHOWN ARE SUPPLIED FOR INFORMATION PURPOSES ONLY, AND IMPLY NO GUARANTEE OF ACCURACY. IT SHALL BE THE RESPONSIBILITY OF THE CONTRACTOR TO VERIFY
- 2. THIS PLAN IS NOT A CADASTRAL SURVEY SHOWING LEGAL PROPERTY BOUNDARIES AND EASEMENTS. THE PROPERTY BOUNDARIES SHOWN HEREON HAVE BEEN DERIVED INFORMATION SUPPLIED BY (OR SHOWN ON) ANNIS, O'SULLIVAN, VOLLEBEKK LTD, DRAWING 17446-21 AND CANNOT BE RELIED UPON TO BE ACCURATE OR COMPLETE. THE PRECISE LOCATION OF THE CURRENT PROPERTY BOUNDARIES AND EASEMENTS CAN ONLY BE DETERMINED BY AN UP-TO-DATE LAND TITLES SEARCH AND A SUBSEQUENT CADASTRAL SURVEY PERFORMED AND CERTIFIED BY AN ONTARIO LAND SURVEYOR.
- . THE CONTRACTOR IS TO OBTAIN AND PAY FOR ALL NECESSARY PERMITS AND APPROVALS FROM THE TOWN BEFORE COMMENCING CONSTRUCTION.
- 4. THE CONTRACTOR IS RESPONSIBLE FOR ALL LAYOUT. 5. THE CONTRACTOR IS TO DETERMINE THE EXACT LOCATION, SIZE, MATERIAL AND ELEVATION OF ALL EXISTING UTILITIES PRIOR TO COMMENCING CONSTRUCTION. PROTECT AND ASSUME ALL RESPONSIBILITY FOR EXISTING UTILITIES WHETHER

OR NOT SHOWN ON THESE DRAWINGS. IF THERE IS ANY DISCREPANCY THE

6. RESTORE ALL TRENCHES AND SURFACES OF PUBLIC ROAD ALLOWANCES TO CONDITION EQUAL OR BETTER THAN ORIGINAL CONDITION AND TO THE SATISFACTION OF THE TOWN AUTHORITIES.

CONTRACTOR IS TO NOTIFY THE ENGINEER PROMPTLY.


- 7. EXCAVATE AND DISPOSE OF ALL EXCESS EXCAVATED MATERIAL, SUCH AS
- ASPHALT, CURBING AND DEBRIS, OFF SITE AS DIRECTED BY THE ENGINEER AND
- 8. TOPSOIL TO BE STRIPPED AND STOCKPILED FOR REHABILITATION. CLEAN FILL TO BE PLACED IN FILL AREAS AND COMPACTED TO 95% STANDARD PROCTOR
- 9. ALL DISTURBED AREAS TO BE RESTORED TO ORIGINAL CONDITION OR BETTER UNLESS OTHERWISE SPECIFIED.


- 10. THE CONTRACTOR SHALL BE RESPONSIBLE FOR ALL TRAFFIC CONTROL AND SAFETY MEASURES DURING THE CONSTRUCTION PERIOD, INCLUDING THE SUPPLY, INSTALLATION, AND REMOVAL OF ALL NECESSARY SIGNAGE, DELINEATORS, MARKERS AND BARRIERS. 11. DO NOT ALTER GRADING OF THE SITE WITHOUT PRIOR APPROVAL OF THE
- ENGINEER/TOWN. 12. ALL ROADWAY, PARKING LOT, AND GRADING WORKS TO BE UNDERTAKEN IN ACCORDANCE WITH TOWN STANDARDS AND SPECIFICATIONS. THE CONTRACTOR IS TO PROVIDE POSITIVE DRAINAGE AWAY FROM THE BUILDING. 13. CONTACT THE TOWN FOR INSPECTION OF ROUGH GRADING OF PARKING LOTS. ROADWAYS AND LANDSCAPED AREAS PRIOR TO PLACEMENT OF ASPHALT AND


TOPSOIL. ALL DEFICIENCIES NOTED SHALL BE RECTIFIED TO THE TOWN'S

SATISFACTION PRIOR TO PLACEMENT OF ANY ASPHALT, TOPSOIL, SEED & MULCH

- 14. ALL DIMENSIONS AND INVERTS MUST BE VERIFIED PRIOR TO CONSTRUCTION, IF THERE IS ANY DISCREPANCY THE CONTRACTOR IS TO NOTIFY THE ENGINEER
- 15. ELECTRICAL, GAS, TELEPHONE AND TELEVISION SERVICE LOCATIONS ARE SUBJECT TO THE INDIVIDUAL AGENCY: ELECTRICAL SERVICE - HYDRO ONE, TELEPHONE SERVICE - BELL CANADA.
- 16. INSTALLATION TO BE IN ACCORDANCE WITH CURRENT CODES AND STANDARDS OF APPROVAL AGENCIES HYDRO ONE, BELL AND THE TOWN.
- 17. CONTRACTOR TO ENSURE ALL APPLICABLE OPS SPECIFICATIONS ARE FOLLOWED DURING CONSTRUCTION
- 18. ALL PROPOSED CURB TO BE CONCRETE BARRIER CURB UNLESS OTHERWISE

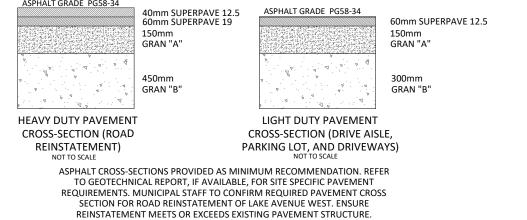

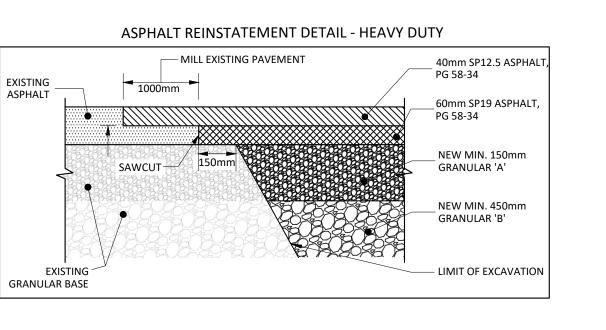

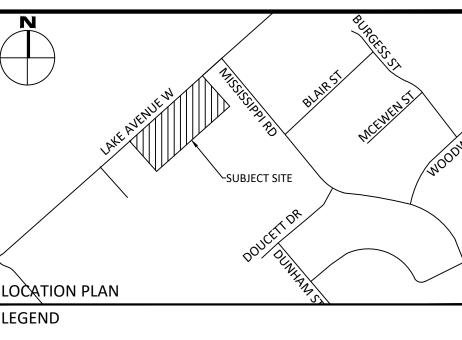


	CONCRETE BARRIER CURB		LIMIT OF CONSTRU
# A -4 -4	CONCRETE WALKWAY		DRAINAGE SWALE
	PROPOSED ASPHALT	··	DRAINAGE DITCH
	MUD MAT		SLOPING AT 3:1 UNLESS SPECIFIED
○MH# T/G	STORM SEWER MANHOLE	95 <u>,</u> 50	SURFACE ELEVATION
CBMH#	CATCHBASIN MANHOLE	×95.50 (s)	SWALE/DITCH ELEVA
■CB# T/G	CATCHBASIN	T/W95.50 B/W94.25	TOP OF WALL ELEVA BOTTOM OF WALL E
MH#A T/G	SANITARY SEWER MANHOLE		OVERLAND FLOW RO
→ HYD B/F	FIRE HYDRANT	<b>-</b>	SILT FENCE BARRIER
0	WATER VALVE		STRAW BALE CHECK
M	WATER METER		
(RM)	REMOTE WATER METER		


3	ISSUED FOR REVIEW	FEB. 20, 2025
2	ISSUED FOR REVIEW	APR 18, 2024
1	ISSUED FOR REVIEW	FEB. 08, 2023
No.	Revisions	Date
Check before	and verify all dimensions proceeding with the work Do n	ot scale drawings

SCALE	1:250				
0	5	10	15	20	25 Met

# McINTOSH PERRY

115 Walgreen Road, RR3, Carp, ON KOA 1L0 Tel: 613-836-2184 Fax: 613-836-3742 www.mcintoshperry.com

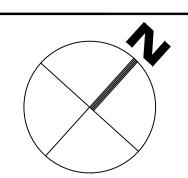

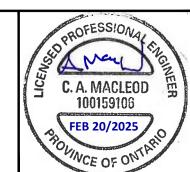

**ESCAPE HOMES** 254 LAKE AVENUE WEST CARLETON PLACE, ON K7C 1M4

254 LAKE AVENUE WEST

GRADING AND DRAINAGE PLAN

cale:	1:250	Project Number:	CO-22-1448	×
rawn By:	FV		CO-22-1448	X-C
checked By:	AM	Drawing Number:		7-1
esigned By:	AG		C101	

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- MATERIAL, SUCH AS ASPHALT, CURBING AND DEBRIS, OFF SITE AS DIRECTED BY THE ENGINEER AND THE TOWN.
- 8. TOPSOIL TO BE STRIPPED AND STOCKPILED FOR REHABILITATION. CLEAN FILL TO BE PLACED IN FILL AREAS AND COMPACTED TO 95% STANDARD PROCTOR DENSITY.

ENGINEER PROMPTLY.

9. ALL DISTURBED AREAS TO BE RESTORED TO ORIGINAL CONDITION OR BETTER UNLESS OTHERWISE SPECIFIED.

- CONSTRUCTION PERIOD. INCLUDING THE SUPPLY. INSTALLATION, AND REMOVAL OF ALL NECESSARY SIGNAGE, DELINEATORS, MARKERS AND BARRIERS. 11. DO NOT ALTER GRADING OF THE SITE WITHOUT PRIOR
- APPROVAL OF THE ENGINEER/TOWN. 2. ALL ROADWAY, PARKING LOT, AND GRADING WORKS TO BE UNDERTAKEN IN ACCORDANCE WITH TOWN STANDARDS AND SPECIFICATIONS. THE CONTRACTOR IS
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- AND TOPSOIL. ALL DEFICIENCIES NOTED SHALL BE RECTIFIED TO THE TOWN'S SATISFACTION PRIOR TO PLACEMENT OF ANY ASPHALT, TOPSOIL, SEED & MULCH AND/OR SOD.
- 14. ALL DIMENSIONS AND INVERTS MUST BE VERIFIED PRIOR TO CONSTRUCTION, IF THERE IS ANY DISCREPANCY THE CONTRACTOR IS TO NOTIFY THE ENGINEER PROMPTLY.
- 15. ELECTRICAL, GAS, TELEPHONE AND TELEVISION SERVICE LOCATIONS ARE SUBJECT TO THE INDIVIDUAL AGENCY: • ELECTRICAL SERVICE - HYDRO ONE, • GAS SERVICE - ENBRIDGE, • TELEPHONE SERVICE - BELL CANADA, • TELEVISION SERVICE - ROGERS.
- 16. INSTALLATION TO BE IN ACCORDANCE WITH CURRENT CODES AND STANDARDS OF APPROVAL AGENCIES HYDRO ONE, BELL AND THE TOWN. 17. CONTRACTOR TO ENSURE ALL APPLICABLE OPS
- SPECIFICATIONS ARE FOLLOWED DURING CONSTRUCTION 18. ALL PROPOSED CURB TO BE CONCRETE BARRIER CURB UNLESS OTHERWISE SPECIFIED.

- 1. CONSTRUCT ALL WATERMAINS AND APPURTENANCES IN ACCORDANCE WITH OPSD STANDARDS AND SPECIFICATIONS, AS
- WELL AS TOWN STANDARDS. RESIDENTIAL SERVICE CONNECTIONS TO BE 19-38mm SDR9 PEX
- (CTS) AND SHALL CONFORM TO ASTM F876. WATERMAINS AND/OR WATER SERVICES ARE TO HAVE A MINIMUM COVER OF 2.4m. OTHERWISE THERMAL INSULATION IS REQUIRED AS
- PER CITY STANDARDS (IF AVAILABLE) OR OPSD 1109.030. 4. WATERMAINS AND/OR WATER SERVICES SHALL HAVE A MINIMUM
- COVER OF 1.8m UNDER DITCH CROSSINGS, OTHERWISE THERMAL INSULATION IS TO BE PROVIDED PER OPSD 1109.030 IF THE WATERMAIN MUST BE DEFLECTED TO MEET ALIGNMENT,
- ENSURE THAT THE AMOUNT OF DEFLECTION USED IS EQUAL TO OR LESS THAN THAT WHICH IS RECOMMENDED BY THE MANUFACTURER.
- THERMAL INSULATION OF WATERMAINS AT OPEN STRUCTURES AS PER TOWN STANDARDS (IF AVAILABLE) OR OPSD 1109.030.
- VALVES TO BE OPERATED BY TOWN STAFF ONLY. 8. NO CONNECTION TO EXISTING WATER NETWORK SHALL BE
- COMPLETED UNTIL A WATER PERMIT IS OBTAINED FROM THE TOWN. TOWN TO BE PRESENT FOR WATERMAIN CONNECTION. CONNECTION, EXCAVATION, BACKFILLING AND REINSTATEMENT TO BE COMPLETED BY CONTRACTOR.
- 9. IT WILL BE THE RESPONSIBILITY OF THE CONTRACTOR TO PERFORM ANY WATERMAIN CONNECTION(S) REQUIRED. THIS SHALL BE COMPLETED IN THE PRESENCE OF A DESIGNATED MUNICIPAL WATER OPERATOR AND THE SELECTED CONTRACTOR SHALL PROVE TO THE SATISFACTION OF THE TOWN THAT THEY ARE COMPETENT TO PERFORM THE WORKS PRIOR TO INITIATING CONSTRUCTION.

10. ALL WATERMAINS SHALL BE EQUIPPED WITH BUTTERFLY AND GATE

- VALVES AS PER OPSD 1100.011. 11. ALL FIRE HYDRANTS, VALVE AND VALVE BOX HSALL CONFORM TO
- 12. CONCRETE THRUST BLOCKS TO CONFORM TO OPSD 1103.010 AND
- 13. ALL WATERMAIN TO BE CLASS 150 DR-18 OR APPROVED 14. ALL WATERMAIN TO BE EQUIPPED WITH TRACER WIRE.

- 1. CONSTRUCT ALL SEWERS, CATCH BASINS, MANHOLES AND APPURTENANCES IN ACCORDANCE WITH OPSD STANDARDS AND SPECIFICATIONS, AS WELL AS TOWN STANDARDS...
- 2. SEWER TRENCHING AND BEDDING SHALL CONFORM TO OPSD 802.010 AND 802.013 UNLESS NOTED OTHERWISE. 2.1. BEDDING SHALL BE A MINIMUM 150mm OF GRANULAR "A", COMPACTED TO MINIMUM 95% STANDARD PROCTOR DRY DENSITY. CLEAR STONE
- BEDDING SHALL NOT BE PERMITTED. SUB-BEDDING, IF REQUIRED SHALL CONSIST OF 450mm OF COMPACTED
- GRANULAR "B" TYPE 1. 2.3. BACKFILL TO AT LEAST 300mm ABOVE TOP OF PIPE WITH GRANULAR "A" OR GRANULAR "B" TYPE 1. 2.4. TO MINIMIZE DIFFERENTIAL FROST HEAVING, TRENCH BACKFILL (FROM

PAVEMENT SUBGRADE TO 2.0 METRES BELOW FINISHED GRADE) SHALL

- 3. SANITARY SEWERS AND CONNECTIONS 150mmØ AND SMALLER TO BE PVC
- 4. SEWERS AND CONNECTIONS 200mmØ AND LARGER TO BE PVC SDR-35. BEDDING TO BE TYPE "B" EXCEPT AT RISERS, UNLESS NOTED OTHERWISE.


MATCH EXISTING SOIL CONDITIONS.

- . INSULATE ALL STORM AND SANITARY SEWERS/SERVICES THAT HAVE LESS THAN 1.5m OF COVER WITH THERMAL INSULATION AS PER OPSD 1109.030.
- 6. SEWER CONNECTIONS ARE TO BE MADE ABOVE THE SPRINGLINE OF THE SEWERMAIN AS PER CITY OF OTTAWA STANDARD DRAWING S11, S11.1 & S11.2.
- SUPPLY AND INSTALL ALL PIPING AND APPURTENANCES AS SHOWN AND DETAILED TO WITHIN 1.0m OF BUILDING. ALL ENDS OF SERVICES TO BE PROPERLY CAPPED AND LOCATED WITH 2"x4"X8' LONG MARKER.
- 8. CONTRACTOR TO TELEVISE (CCTV) ALL PROPOSED SEWERS ON SITE, OUTLET CONNECTION TO THE MAIN AND PIPES 150mmØ OR GREATER PRIOR TO BASE COURSE ASPHALT. UPON COMPLETION OF CONTRACT, THE CONTRACTOR IS RESPONSIBLE TO FLUSH AND CLEAN ALL SEWERS & APPURTENANCES.
- 9. DYE TESTING IS TO BE COMPLETED ON SANITARY SERVICE TO CONFIRM PROPER CONNECTION TO SANITARY SEWER MAIN.

	CROSSING CONFLICT TABLE	
CATION	DESCRIPTION	SEPARATION
4	38mmØ WTR SERVICE INV 135.52	0.50
1	200mmØ SAN SEWER OBV 135.02	0.50
2	38mmØ WTR SERVICE INV 135.50	0.52
2	200mmØ SAN SEWER OBV 134.98	0.52
3	38mmØ WTR SERVICE INV 135.64	0.84
3	200mmØ SAN SEWER OBV 134.80	0.04
4	38mmØ WTR SERVICE INV 135.70	1.04
7	200mmØ SAN SEWER OBV 134.74	1.04
5	19mmØ WTR SERVICE INV 135.87	1.23
,	200mmØ SAN SEWER OBV 134.64	1.25
6	19mmØ WTR SERVICE INV 135.90	1.31
0	200mmØ SAN SEWER OBV 134.59 19mmØ WTR SERVICE INV 136.07	1.51
7		1.53
,	200mmØ SAN SEWER OBV 134.54	1.55
8	200mmØ SUBDRAIN INV 136.39	1.23
9	300mmØ WTR MAIN OBV 135.16	1.25

	STM STRUCTURE TABLE					
NAME	RIM ELEV.	INVERT IN	INVERT OUT	DESCRIPTION		
CICB8	137.00		SE136.158	COVER: OPSD 401.080 FRAME: OPSD 400.082 STRUC: OPSD 705.010		
CICB9	137.47	NW136.363	SE136.305	COVER: OPSD 401.080 FRAME: OPSD 400.082 STRUC: OPSD 705.010		
LSCB1	136.47	SE136.040	NW136.040	PER CITY OF OTTAWA STANDARD S30		
LSCB2	136.65	NE136.195	NW136.195	PER CITY OF OTTAWA STANDARD S30		
LSCB3	136.83	NE136.350	SW136.350	PER CITY OF OTTAWA STANDARD S30		
LSCB4	137.02		SW136.550	PER CITY OF OTTAWA STANDARD S31		
LSCB5	136.64	NE136.031	SW136.031	PER CITY OF OTTAWA STANDARD S30		
LSCB6	136.75	NE136.140	SW136.140	PER CITY OF OTTAWA STANDARD S30		
LSCB7	136.82		SW136.280	PER CITY OF OTTAWA STANDARD S31		

NAME	RIM ELEV.	INVERT IN	INVERT OUT	DESCRIPTION
EX. MH	140.38	NW138.960		EXISTING SANITARY MH
MH1A	137.09	\$134.920	NE134.890	STRUC OPSD 701.010 FRAME OPSD 401.010 COVER OPSD 401.010 TYPE A
MH2A	137.40	SW134.640	NE134.620	STRUC OPSD 701.010 FRAME OPSD 401.010 COVER OPSD 401.010 TYPE A
МНЗА	137.89	SW134.326 SE134.360	E134.300	STRUC OPSD 701.010 FRAME OPSD 401.010 COVER OPSD 401.010 TYPE A
МН4А	137.96	W134.271	SE134.240	STRUC OPSD 701.010 FRAME OPSD 401.010 COVER OPSD 401.010 TYPE A
МН5А	140.01	SW139.070	SE139.010	STRUC OPSD 701.010 FRAME OPSD 401.010 COVER OPSD 401.010 TYPE A
PUMP STATION	138.75	NW134.126	NE136.550	EONE DESIGN (BY OTHERS)

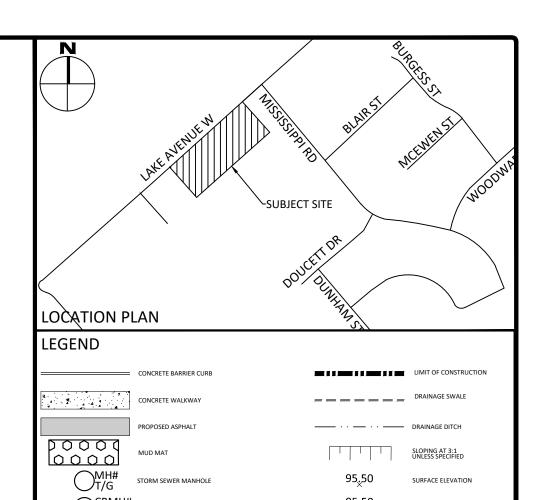


TOP OF WALL ELEVATION BOTTOM OF WALL ELEVATIO


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S	CALE	1:250				
F		5	10	15	20	25 Metr

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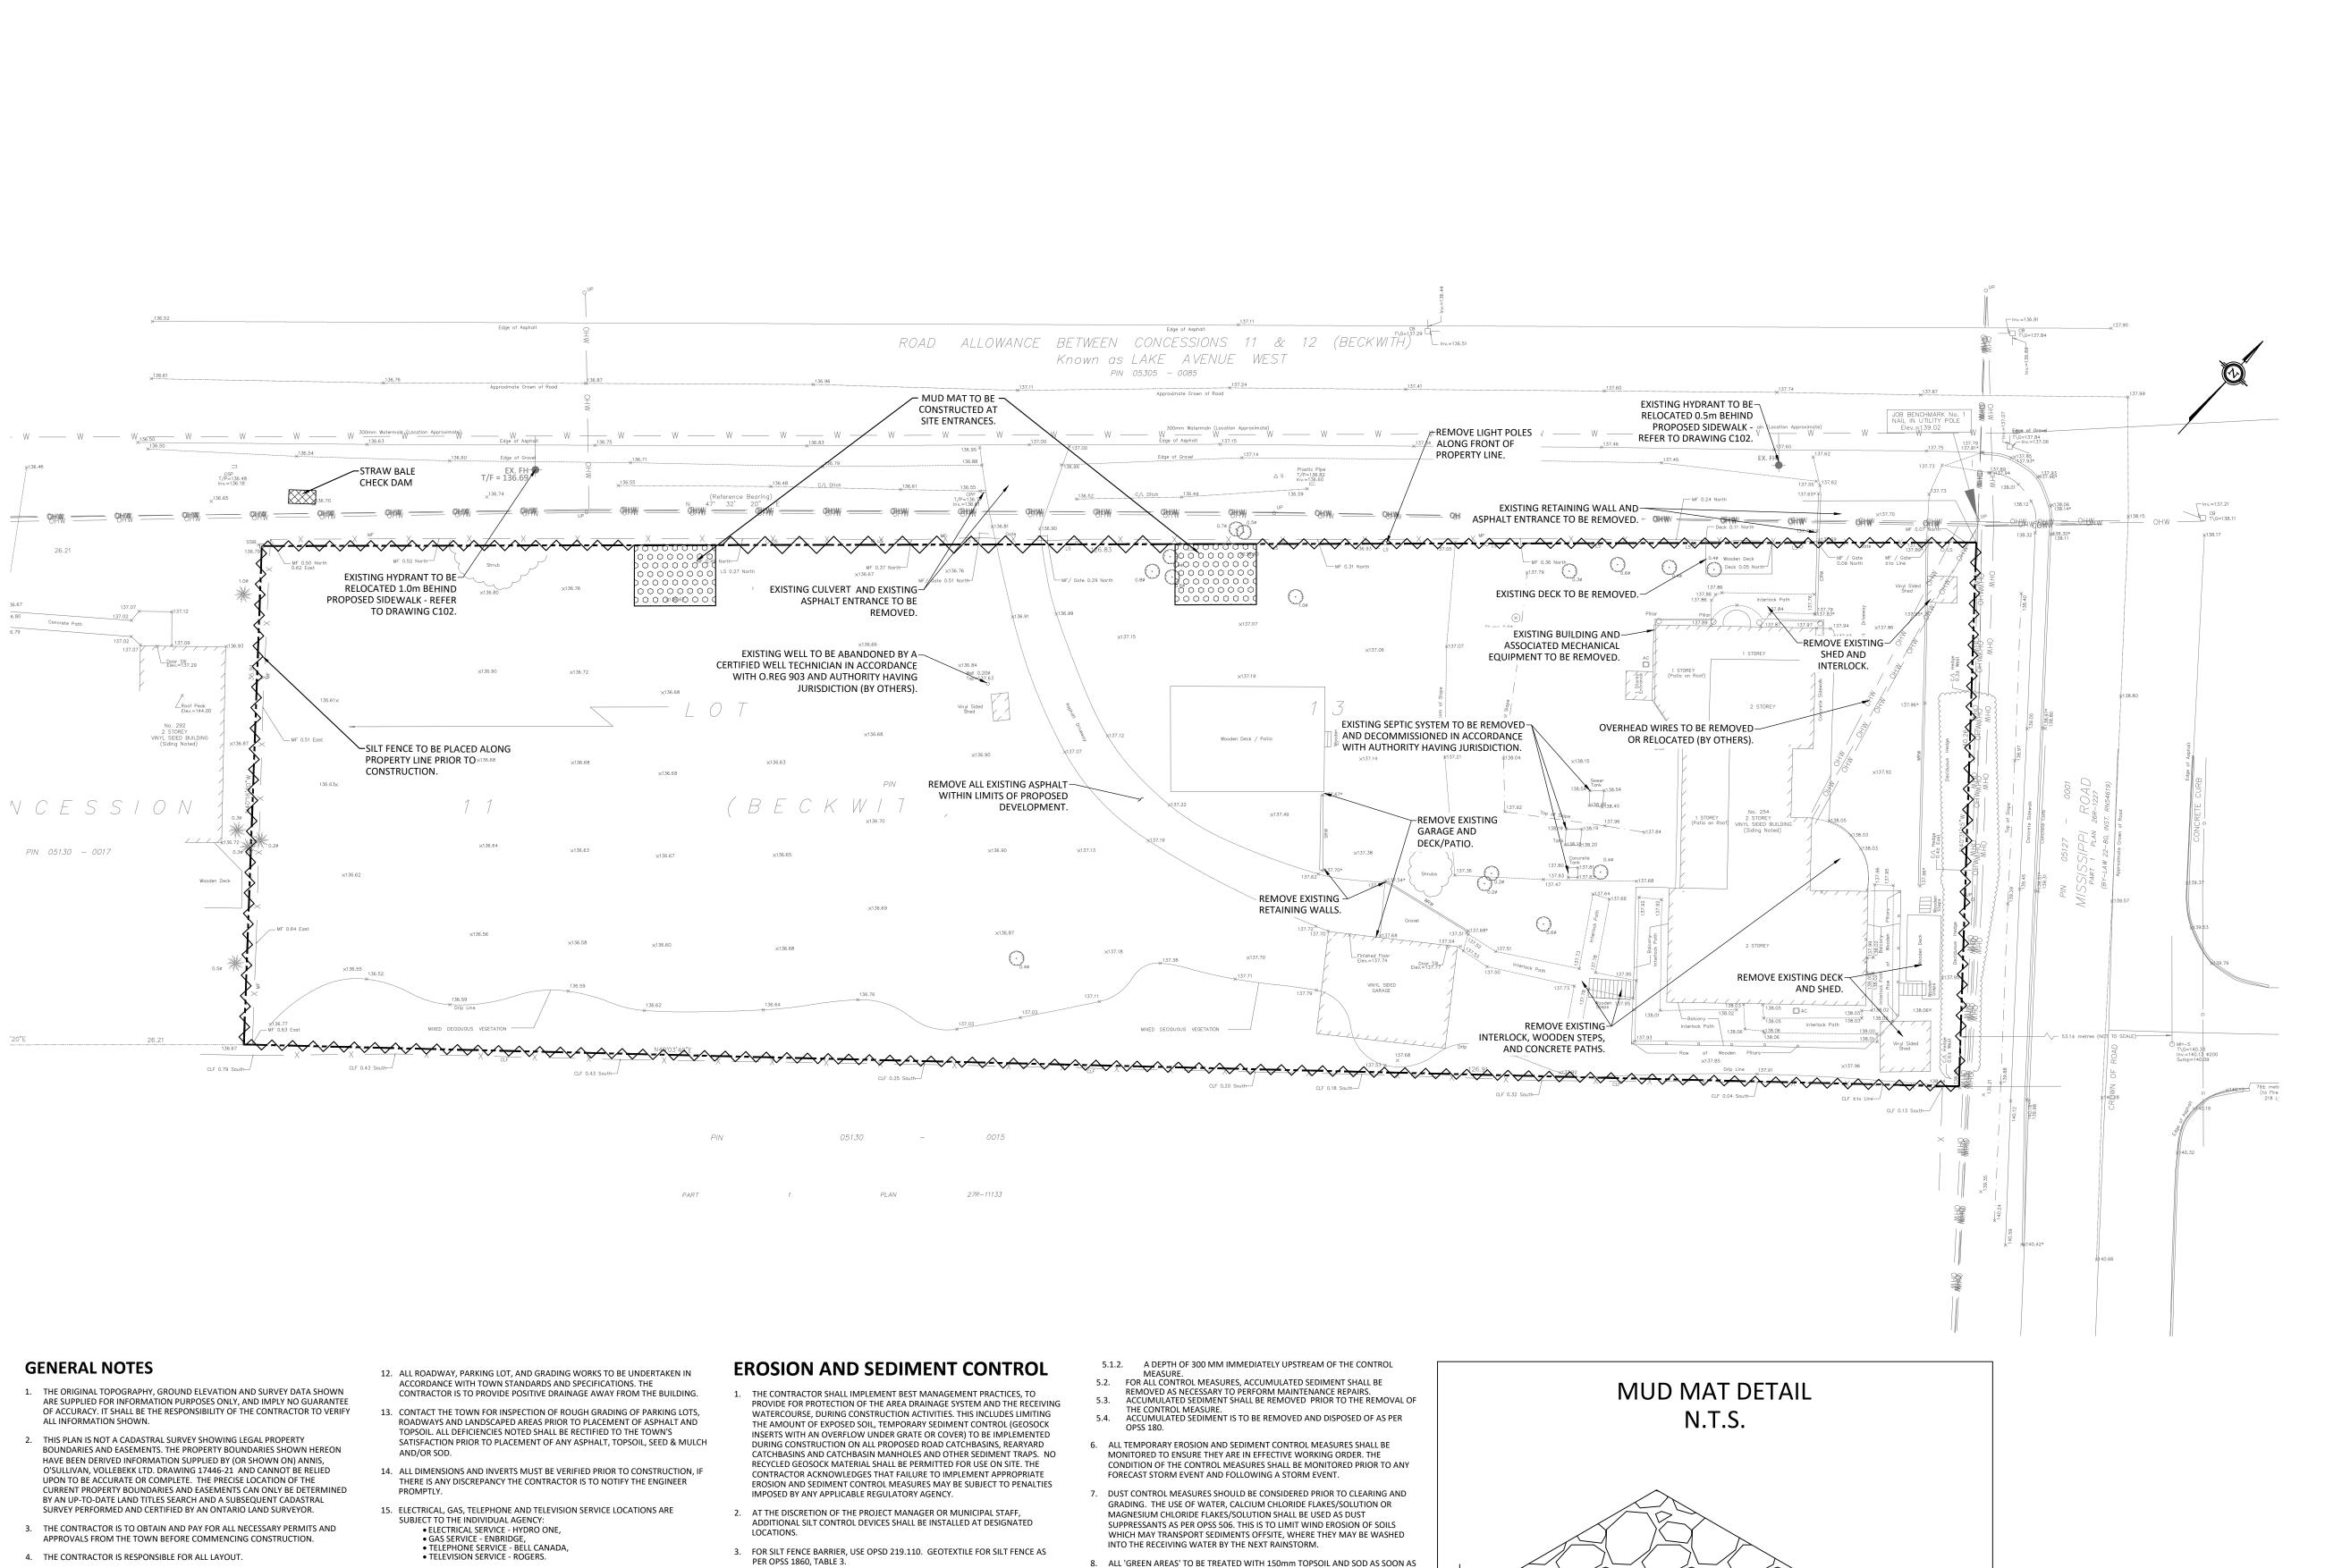
**ESCAPE HOMES** 254 LAKE AVENUE WEST CARLETON PLACE, ON K7C 1M4

**254 LAKE AVENUE WEST** 

Drawing Title:

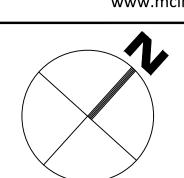SITE SERVICING PLAN

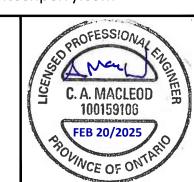Scale:	1:250	Project Number:	
Drawn By:	FV		CO-22-1448
Checked By:	AM	Drawing Number:	
Designed By:			C102



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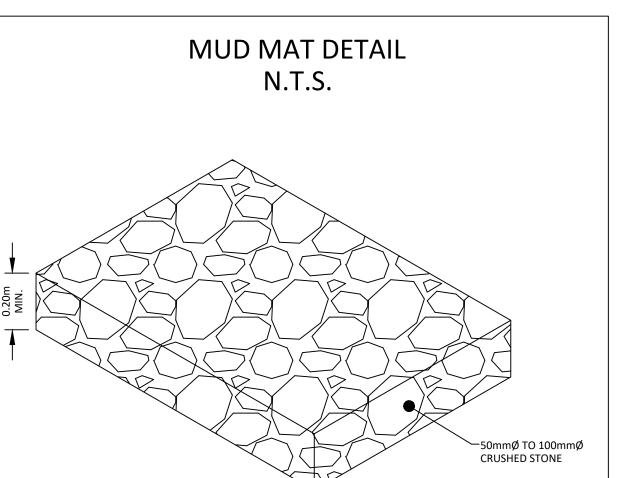
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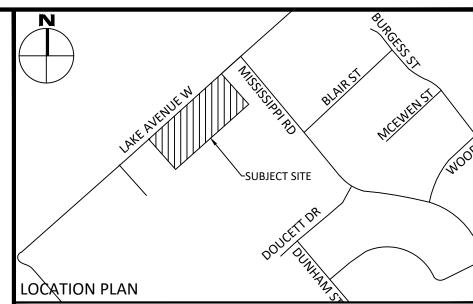
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- 18. ALL PROPOSED CURB TO BE CONCRETE BARRIER CURB UNLESS OTHERWISE
- THAN 21 DAYS) THEN STABILIZATION MEASURES DO NOT HAVE TO BE INITIATED ON THAT PORTION OF SITE BY THE 14TH DAY AFTER

5. SEDIMENT THAT IS ACCUMULATED BY THE TEMPORARY EROSION AND

- AVOIDS ESCAPE OF THE SEDIMENT TO THE DOWNSTREAM SIDE OF THE CONTROL MEASURE AND AVOIDS DAMAGE TO THE CONTROL MEASURE. SEDIMENT SHALL BE REMOVED TO THE LEVEL OF THE GRADE EXISTING AT THE TIME THE CONTROL MEASURE WAS CONSTRUCTED AND BE ACCORDING TO THE 5.1. FOR LIGHT-DUTY SEDIMENT BARRIERS, ACCUMULATED SEDIMENT SHALL BE
- PER OPSS 1860, TABLE 3.
- 4. EXCEPT AS PROVIDED IN PARAGRAPHS 4.1., and 4.2. BELOW, STABILIZATION MEASURES SHALL BE INITIATED AS SOON AS FEASIBLE IN PORTIONS OF THE SITE WHERE CONSTRUCTION ACTIVITIES HAVE TEMPORARILY OR PERMANENTLY UNLESS OTHERWISE SPECIFIED. CFASED. BUT IN NO CASE MORE THAN 14 DAYS AFTER THE CONSTRUCTION ACTIVITY HAS TEMPORARILY OR PERMANENTLY CEASED.
- 4.1. WHERE THE INITIATION OF STABILIZATION MEASURES BY THE 14TH DAY AFTER CONSTRUCTION ACTIVITY TEMPORARILY OR PERMANENTLY CEASE IS PRECLUDED BY SNOW COVER, STABILIZATION MEASURES SHALL BE INITIATED AS SOON AS FEASIBLE.
  WHERE CONSTRUCTION ACTIVITY WILL RESUME ON A PORTION OF THE SITE WITHIN 21 DAYS FROM WHEN ACTIVITIES CEASED, (E.G. THE TOTAL TIME PERIOD THAT CONSTRUCTION ACTIVITY IS TEMPORARILY CEASED IS LESS
- SEDIMENT CONTROL MEASURES SHALL BE REMOVED IN A MANNER THAT 12. ALL EROSION AND SEDIMENT CONTROL MEASURES SHALL CONFORM TO OPSS
- REMOVED ONCE IT REACHES THE LESSER OF THE FOLLOWING:
  5.1.1. A DEPTH OF ONE-HALF THE EFFECTIVE HEIGHT OF THE CONTROL
- FEASIBLE, AS PER OPSS 570. ALL DISTURBED AREAS TO BE RESTORED TO ORIGINAL CONDITION OR BETTER
- 10. STOCKPILED MATERIAL IS TO BE STORED AWAY FROM POTENTIAL RECEIVERS (E.G. STORM CATCHBASINS, MANHOLES). AND BE SURROUNDED BY EROSION CONTROL MEASURES WHERE MATERIAL IS LEFT IN PLACE IN EXCESS OF 14 DAYS.
- . IF REQUIRED, DEWATERING/SETTLING BASINS SHALL BE CONSTRUCTED AS PER OPSD 219.240 AND LOCATED ON FLAT GRADE UPSTREAM OF OTHER EXISTING MITIGATION MEASURES. WATERCOURSES SHALL NOT BE DIVERTED, OR BLOCKED, AND TEMPORARY WATERCOURSES CROSSINGS SHALL NOT BE CONSTRUCTED OR UTILIZED, UNLESS OTHERWISE SPECIFIED IN THE CONTRACT. IF CLOSURE OF ANY PERMANENT WATER PASSAGE IS NECESSARY, THE CONTRACTOR SHALL RELEASE ANY STRANDED FISH TO THE OPEN PORTION OF THE WATERCOURSE WITHOUT HARM.
- 13. WHERE DEWATERING IS REQUIRED, THE DISCHARGED WATER SHALL BE CONTROLLED IN ACCORDANCE WITH OPSS 518.
- 14. ALL SETTLING/FILTRATION BASINS SHALL BE EQUIPPED WITH TERRAFIX 270R GEOTEXTILE (OR APPROVED EQUIVALENT) AND SHALL BE CLEANED AND REPLACED AS REQUIRED.





LEGEND

REMOTE WATER METER

×T/W 95.50 B/W 94.25

SILT FENCE BARRIER


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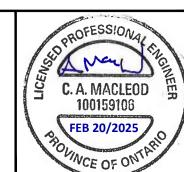
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**ESCAPE HOMES** 254 LAKE AVENUE WEST CARLETON PLACE, ON K7C 1M4

**254 LAKE AVENUE WEST** 

REMOVALS, EROSION AND SEDIMENT **CONTROL PLAN** 


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rawn By:	FV		CO-22-1448
necked By:	AM	Drawing Number:	
esigned By:	AG		C103

0+040

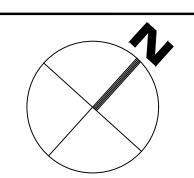
-0+010

0+000

0+020

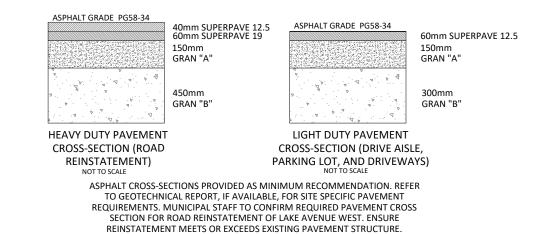

### ASPHALT REINSTATEMENT DETAIL - HEAVY DUTY

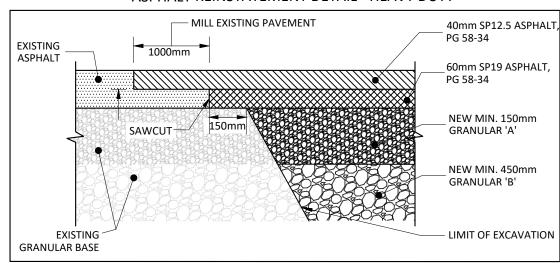

SAN STRUCTURE TABLE					
NAME	RIM ELEV.	INVERT IN	INVERT OUT	DESCRIPTION	
EX. MH	140.38	NW138.960		EXISTING SANITARY MH	
МН5А	140.01	SW139.070	SE139.010	STRUC OPSD 701.010 FRAME OPSD 401.010 COVER OPSD 401.010 TYPE A	
PUMP STATION	138.75	NW134.126	NE136.550	EONE DESIGN (BY OTHERS)	

### **GENERAL NOTES**

0+070

0+060

- THE ORIGINAL TOPOGRAPHY, GROUND ELEVATION AND SURVEY DATA SHOWN ARE SUPPLIED FOR INFORMATION PURPOSES ONLY, AND IMPLY NO GUARANTEE OF ACCURACY, IT SHALL BE THE RESPONSIBILITY OF THE
- CONTRACTOR TO VERIFY ALL INFORMATION SHOWN. THIS PLAN IS NOT A CADASTRAL SURVEY SHOWING LEGAL PROPERTY BOUNDARIES AND EASEMENTS. THE PROPERTY BOUNDARIES SHOWN HEREON HAVE BEEN DERIVED INFORMATION SUPPLIED BY (OR SHOWN ON) ANNIS, O'SULLIVAN, VOLLEBEKK LTD. DRAWING 17446-21 AND CANNOT BE RELIED UPON TO BE ACCURATE OR COMPLETE. THE PRECISE LOCATION OF THE CURRENT PROPERTY BOUNDARIES AND EASEMENTS CAN ONLY BE DETERMINED BY AN UP-TO-DATE LAND TITLES SEARCH AND A SUBSEQUENT CADASTRAL SURVEY PERFORMED
- AND CERTIFIED BY AN ONTARIO LAND SURVEYOR. 3. THE CONTRACTOR IS TO OBTAIN AND PAY FOR ALL NECESSARY PERMITS AND APPROVALS FROM THE TOWN BEFORE COMMENCING CONSTRUCTION.
- 4. THE CONTRACTOR IS RESPONSIBLE FOR ALL LAYOUT. 5. THE CONTRACTOR IS TO DETERMINE THE EXACT LOCATION, SIZE, MATERIAL AND ELEVATION OF ALL EXISTING UTILITIES PRIOR TO COMMENCING CONSTRUCTION. PROTECT AND ASSUME ALL RESPONSIBILITY FOR EXISTING UTILITIES WHETHER OR NOT SHOWN ON THESE DRAWINGS. IF THERE IS ANY DISCREPANCY THE CONTRACTOR IS TO NOTIFY THE

ENGINEER PROMPTLY.

- 6. RESTORE ALL TRENCHES AND SURFACES OF PUBLIC ROAD ALLOWANCES TO CONDITION EQUAL OR BETTER THAN ORIGINAL CONDITION AND TO THE SATISFACTION OF THE
- 7. EXCAVATE AND DISPOSE OF ALL EXCESS EXCAVATED MATERIAL, SUCH AS ASPHALT, CURBING AND DEBRIS, OFF SITE AS DIRECTED BY THE ENGINEER AND THE TOWN.
- 8. TOPSOIL TO BE STRIPPED AND STOCKPILED FOR REHABILITATION. CLEAN FILL TO BE PLACED IN FILL AREAS AND COMPACTED TO 95% STANDARD PROCTOR DENSITY.
- 9. ALL DISTURBED AREAS TO BE RESTORED TO ORIGINAL CONDITION OR BETTER UNLESS OTHERWISE SPECIFIED.

- 10. THE CONTRACTOR SHALL BE RESPONSIBLE FOR ALL TRAFFIC CONTROL AND SAFETY MEASURES DURING THE CONSTRUCTION PERIOD, INCLUDING THE SUPPLY, INSTALLATION, AND REMOVAL OF ALL NECESSARY SIGNAGE, DELINEATORS, MARKERS AND BARRIERS.
- 11. DO NOT ALTER GRADING OF THE SITE WITHOUT PRIOR APPROVAL OF THE ENGINEER/TOWN. 12. ALL ROADWAY, PARKING LOT, AND GRADING WORKS TO BE UNDERTAKEN IN ACCORDANCE WITH TOWN

TO PROVIDE POSITIVE DRAINAGE AWAY FROM THE

STANDARDS AND SPECIFICATIONS. THE CONTRACTOR IS

13. CONTACT THE TOWN FOR INSPECTION OF ROUGH GRADING OF PARKING LOTS, ROADWAYS AND LANDSCAPED AREAS PRIOR TO PLACEMENT OF ASPHALT AND TOPSOIL. ALL DEFICIENCIES NOTED SHALL BE RECTIFIED TO THE TOWN'S SATISFACTION PRIOR TO PLACEMENT OF ANY ASPHALT, TOPSOIL, SEED & MULCH

AND/OR SOD.

14. ALL DIMENSIONS AND INVERTS MUST BE VERIFIED PRIOR TO CONSTRUCTION, IF THERE IS ANY DISCREPANCY THE CONTRACTOR IS TO NOTIFY THE ENGINEER PROMPTLY.

• TELEVISION SERVICE - ROGERS.

17. CONTRACTOR TO ENSURE ALL APPLICABLE OPS

ONE, BELL AND THE TOWN.

UNLESS OTHERWISE SPECIFIED.

16. INSTALLATION TO BE IN ACCORDANCE WITH CURRENT

18. ALL PROPOSED CURB TO BE CONCRETE BARRIER CURB

CODES AND STANDARDS OF APPROVAL AGENCIES HYDRO

SPECIFICATIONS ARE FOLLOWED DURING CONSTRUCTION

- 8. NO CONNECTION TO EXISTING WATER NETWORK SHALL BE 15. ELECTRICAL, GAS, TELEPHONE AND TELEVISION SERVICE LOCATIONS ARE SUBJECT TO THE INDIVIDUAL AGENCY: ELECTRICAL SERVICE - HYDRO ONE, GAS SERVICE - ENBRIDGE,
   TELEPHONE SERVICE - BELL CANADA, BE COMPLETED BY CONTRACTOR.
  - PERFORM THE WORKS PRIOR TO INITIATING CONSTRUCTION.
  - 10. ALL WATERMAINS SHALL BE EQUIPPED WITH BUTTERFLY AND GATE VALVES AS PER OPSD 1100.011.
  - OPSD 1103.020.
  - 12. CONCRETE THRUST BLOCKS TO CONFORM TO OPSD 1103.010 AND OPSD 1103.020.
  - 13. ALL WATERMAIN TO BE CLASS 150 DR-18 OR APPROVED EQUIVALENT.

## WATERMAIN NOTES

- 1. CONSTRUCT ALL WATERMAINS AND APPURTENANCES IN ACCORDANCE WITH OPSD STANDARDS AND SPECIFICATIONS, AS WELL AS TOWN STANDARDS.
- 2. RESIDENTIAL SERVICE CONNECTIONS TO BE 19-38mm SDR9 PEX (CTS) AND SHALL CONFORM TO ASTM F876. 3. WATERMAINS AND/OR WATER SERVICES ARE TO HAVE A MINIMUM

COVER OF 2.4m. OTHERWISE THERMAL INSULATION IS REQUIRED AS

4. WATERMAINS AND/OR WATER SERVICES SHALL HAVE A MINIMUM COVER OF 1.8m UNDER DITCH CROSSINGS, OTHERWISE THERMAL INSULATION IS TO BE PROVIDED PER OPSD 1109.030

PER CITY STANDARDS (IF AVAILABLE) OR OPSD 1109.030.

- 5. IF THE WATERMAIN MUST BE DEFLECTED TO MEET ALIGNMENT. ENSURE THAT THE AMOUNT OF DEFLECTION USED IS EQUAL TO OR LESS THAN THAT WHICH IS RECOMMENDED BY THE MANUFACTURER.
- 6. THERMAL INSULATION OF WATERMAINS AT OPEN STRUCTURES AS PER TOWN STANDARDS (IF AVAILABLE) OR OPSD 1109.030.
- 7. VALVES TO BE OPERATED BY TOWN STAFF ONLY.
- COMPLETED UNTIL A WATER PERMIT IS OBTAINED FROM THE TOWN. TOWN TO BE PRESENT FOR WATERMAIN CONNECTION. CONNECTION, EXCAVATION, BACKFILLING AND REINSTATEMENT TO
- 9. IT WILL BE THE RESPONSIBILITY OF THE CONTRACTOR TO PERFORM ANY WATERMAIN CONNECTION(S) REQUIRED. THIS SHALL BE COMPLETED IN THE PRESENCE OF A DESIGNATED MUNICIPAL WATER OPFRATOR AND THE SELECTED CONTRACTOR SHALL PROVE TO THE SATISFACTION OF THE TOWN THAT THEY ARE COMPETENT TO
- 11. ALL FIRE HYDRANTS, VALVE AND VALVE BOX HSALL CONFORM TO
- 14. ALL WATERMAIN TO BE EQUIPPED WITH TRACER WIRE.

### **SEWER NOTES:**

- 1. CONSTRUCT ALL SEWERS, CATCH BASINS, MANHOLES AND APPURTENANCES IN ACCORDANCE WITH OPSD STANDARDS AND SPECIFICATIONS, AS WELL AS CITY.
- 2. SEWER TRENCHING AND BEDDING SHALL CONFORM TO OPSD 802.010 AND 802.013 UNLESS NOTED OTHERWISE. 2.1. BEDDING SHALL BE A MINIMUM 150mm OF GRANULAR "A", COMPACTED TO MINIMUM 95% STANDARD PROCTOR DRY DENSITY. CLEAR STONE
- BEDDING SHALL NOT BE PERMITTED. 2.2. SUB-BEDDING, IF REQUIRED SHALL CONSIST OF 450mm OF COMPACTED
- GRANULAR "B" TYPE 1. 2.3. BACKFILL TO AT LEAST 300mm ABOVE TOP OF PIPE WITH GRANULAR "A" OR GRANULAR "B" TYPE 1. 2.4. TO MINIMIZE DIFFERENTIAL FROST HEAVING, TRENCH BACKFILL (FROM

PAVEMENT SUBGRADE TO 2.0 METRES BELOW FINISHED GRADE) SHALL

3. SANITARY SEWERS AND CONNECTIONS 150mmØ AND SMALLER TO BE PVC

MATCH EXISTING SOIL CONDITIONS.

- 4. SEWERS AND CONNECTIONS 200mmØ AND LARGER TO BE PVC SDR-35. BEDDING TO BE TYPE "B" EXCEPT AT RISERS, UNLESS NOTED OTHERWISE.
- INSULATE ALL STORM AND SANITARY SEWERS/SERVICES THAT HAVE LESS THAN
- 1.5m OF COVER WITH THERMAL INSULATION AS PER OPSD 1109.030. 6. SEWER CONNECTIONS ARE TO BE MADE ABOVE THE SPRINGLINE OF THE
- SEWERMAIN AS PER CITY OF OTTAWA STANDARD DRAWING S11, S11.1 & S11.2. SUPPLY AND INSTALL ALL PIPING AND APPURTENANCES AS SHOWN AND


CONNECTION TO THE MAIN AND PIPES 150mmØ OR GREATER PRIOR TO BASE

COURSE ASPHALT. UPON COMPLETION OF CONTRACT, THE CONTRACTOR IS

DETAILED TO WITHIN 1.0m OF BUILDING. ALL ENDS OF SERVICES TO BE PROPERLY CAPPED AND LOCATED WITH 2"x4"X8' LONG MARKER. 8. CONTRACTOR TO TELEVISE (CCTV) ALL PROPOSED SEWERS ON SITE, OUTLET

RESPONSIBLE TO FLUSH AND CLEAN ALL SEWERS & APPURTENANCES.

9. DYE TESTING IS TO BE COMPLETED ON SANITARY SERVICE TO CONFIRM PROPER CONNECTION TO SANITARY SEWER MAIN.

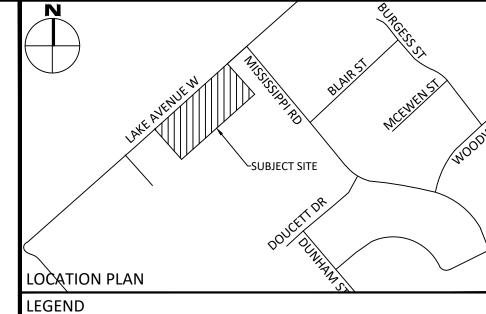

# ----- DRAINAGE DITCH SLOPING AT 3:1 UNLESS SPECIFIED

TOP OF WALL ELEVATION BOTTOM OF WALL ELEVATIO


## NOT FOR CONSTRUCTION


ISSUED FOR REVIEW FEB. 20, 2025 Date

Check and verify all dimensions Do not scale drawings before proceeding with the work SCALE 1:250

# McINTOSH PERRY

115 Walgreen Road, RR3, Carp, ON KOA 1L0 Tel: 613-836-2184 Fax: 613-836-3742 www.mcintoshperry.com

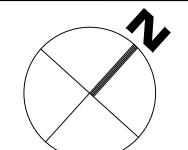

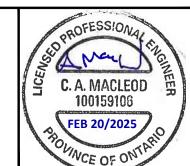

**ESCAPE HOMES** 254 LAKE AVENUE WEST CARLETON PLACE, ON K7C 1M4

254 LAKE AVENUE WEST

OFFSITE SANITARY PLAN & PROFILE

1:250 CO-22-1448 Drawing Number: AM